

NOTES:

1. VERIFY w/ MANUFACTURER'S INSTALLATION MANUAL WHETHER PUMPS ARE MOUNTED VERTICALLY OR HORIZONTALLY.

2. ENSURE PUMP INSTALLED ON TOP IS HIGH ENOUGH FOR ACCESS TO REMOVE PUMP BELOW.

3. SUPPORT PUMPS AS PER MANUFACTURER'S INSTALLATION INSTRUCTIONS.

6 IN-LINE PUMPS DETAIL

NO SCALE

UNIT		CIRCULATING FLUID						%		MOTOR		
NO.	LOCATION	SYSTEM	FLUID	GPM	HEAD (FT.)	TEMP	SP. GR.	EFF.	TYPE	HP	VOLT	PH
51-P10	BASEMENT	HEATING	WATER	135	55	180	0.97	63	IL	5	480	3
51-P11	BASEMENT	HEATING	WATER	135	55	180	0.97	63	IL	5	480	3

1. ALL PUMPS SHALL BE VFD DUTY.
2. THE VFD FOR EACH PUMP SHALL BE SUPPLIED BY THE MECHANICAL CONTRACTOR.


SEE SPEC SECTION 230511, 2.7 FOR MORE DETAILS.


HVAC PIPING NOTES:

- A. CONTRACTOR SHALL VERIFY ALL EXISTING CONDITIONS PRIOR TO BEGINNING WORK AND NOTIFY THE ARCHITECT/ ENGINEER OF ANY DISCREPANCIES BETWEEN THE
- B. COORDINATE ALL HVAC PIPING INSTALLATION WITH GENERAL, PLUMBING, FIRE PROTECTION, VENTILATION, AND ELECTRICAL CONTRACTORS. INSTALL ALL HVAC PIPING AS HIGH AS POSSIBLE. PROVIDE ALL NECESSARY OFFSETS (DROPS AND RISES) TO KEEP HVAC PIPING TIGHT TO THE STRUCTURE OR DUCTWORK ABOVE. OFFSET HVAC PIPING TO AVOID BEAMS.
- REFER TO AND COORDINATE WITH THE ARCHITECTURAL PLANS FOR CEILING TYPES, HEIGHTS, SOFFIT AREAS, AND ELEVATIONS FOR INSTALLATION OF NEW HVAC
- D. THIS CONTRACTOR IS RESPONSIBLE FOR REMOVAL AND RE-INSTALLING OF EXISTING CEILING TILE NOT REMOVED BY THE GENERAL CONTRACTOR FOR THE INSTALLATION OF NEW HVAC PIPING, EQUIPMENT, ETC. VERIFY WITH ARCHITECTURAL PLANS FOR CEILING WORK BY THE GENERAL CONTRACTOR. ANY CEILING TILE OR GRID DAMAGED DURING CONSTRUCTION SHALL BE REPLACED WITH NEW BY THIS CONTRACTOR.
- E. THIS CONTRACTOR SHALL OPEN ALL EXISTING WALLS AND/OR CEILINGS TO INSTALL NEW HVAC PIPING, EQUIPMENT, ETC. AS REQUIRED. PATCH WALLS AND/OR
- CEILINGS TO MATCH EXISTING.

 F. MAINTAIN 3'-O" CLEAR SPACE IN FRONT OF ALL ELECTRICAL, CONTROL, AND ACCESS PANELS FOR ACCESSIBILITY.
- 5. ALL SHUT-OFF VALVES, CONTROL VALVES, STRAINERS, ETC... SHALL BE INSTALLED IN ACCESSIBLE CEILINGS. VALVES SHALL BE LOCATED NOT MORE THAN 2 FEET
- ABOVE ACOUSTICAL CEILINGS.


 PROVIDE I/2" DRAIN VALVE AT ALL LOW POINTS OF EACH SYSTEM TO ENABLE COMPLETE DRAINAGE. PROVIDE I/2" VENT VALVES AT ALL HIGH POINTS OF EACH SYSTEM TO ENABLE COMPLETE VENTING.

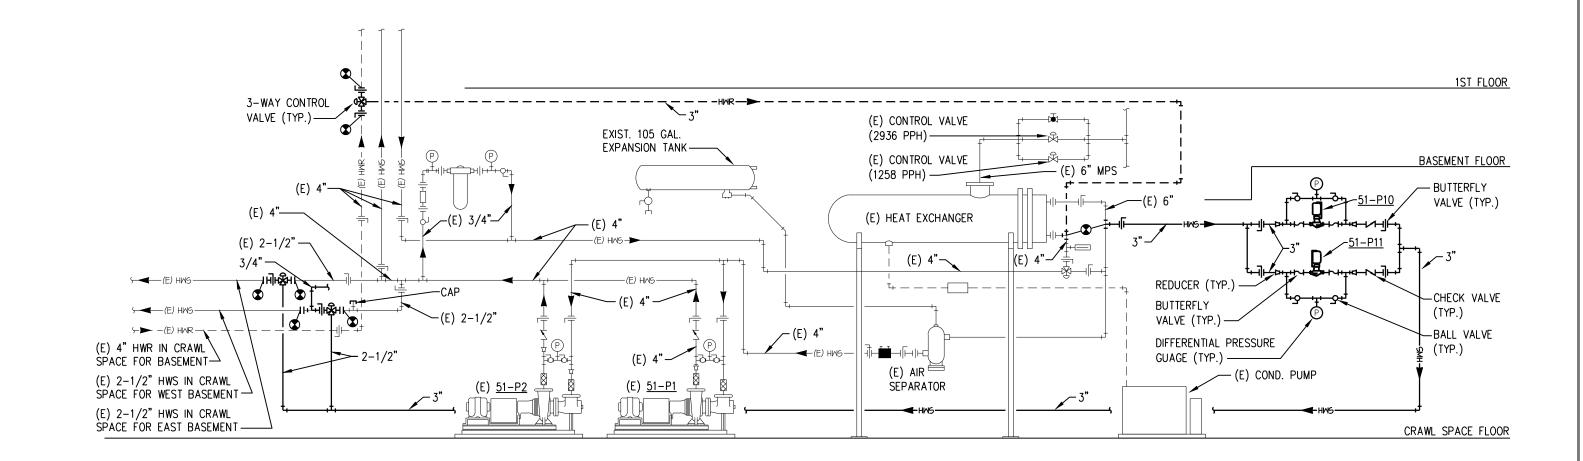

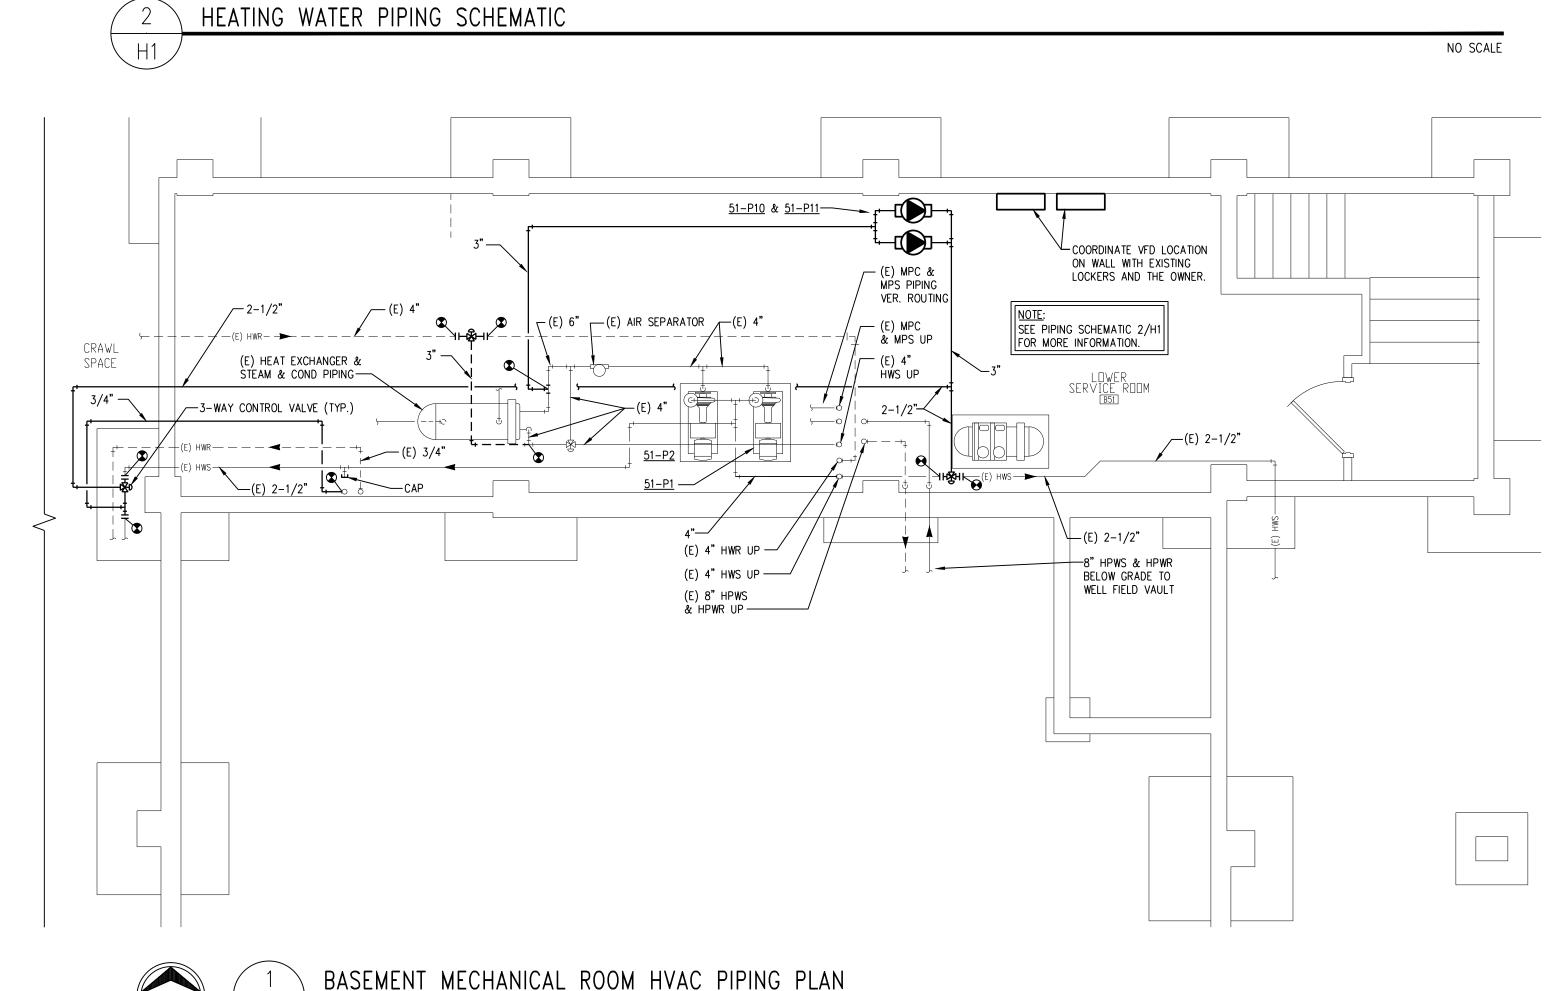





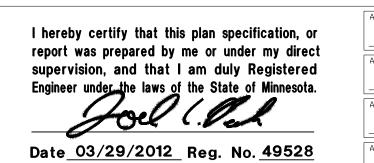

APPROVED: SERVICE LINE DIRECTOR	R DATE:	APPROVED:	INFECTION CONTROL NURSE	DATE:	DRAWING TITLE
					HVAC PIPING PLAN, HEATIN
APPROVED: SERVICE LINE DIRECTOR	R DATE:	APPROVED:	PATIENT SAFETY	DATE:	PIPING SCHEMATIC, HEATING CONTROL DIAGRAM, AND EI PLANS
APPROVED: PROJECTS SECTION MANA	AGER DATE:	APPROVED:	CHIEF OF POLICE	DATE:	APPROVED: CHIEF OF STAFF
APPROVED: DIRECTOR FMS	DATE:	APPROVED:	SAFETY MANAGER	DATE:	APPROVED: MEDICAL CENTER DIRECTOR

PROJECT TITLE

PIPING PLAN, HEATING WATER
SCHEMATIC, HEATING SYSTEM
ROL DIAGRAM, AND ELECTRICAL

CHIEF OF STAFF

DATE:

BUILDING NO

SCHECKED BY

JP/AN

DATE

MARCH 29, 2012

PLOT SCALE

SEE DRAWING

PROJECT NO.

656-12
CHECKED BY


JP/AN

MW

CAD FILE

VA MEDICAL CENTER ST.CLOUD, MN 56303

DATE: LOCATION

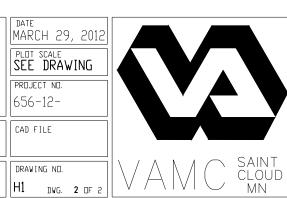

SCALE: 1/4"=1'-0"